


GENERAL NOTES: 1. BUILDING DESIGNATIONS ARE FOR CONSTRUCTION REFERENCE ONLY. VERIFY ACTUAL ADDRESSING OF BUILDINGS & UNITS WITH LOCAL 911 ADDRESSING AUTHORITY. 2. SITE LAYOUT IS PER A SURVEY DATED 05/29/07 BY CENTRAL ARKANSAS PROFESSIONAL SURVEYING, (501) 513.4800.



3. GEOTECHNICAL INFORMATION TO BE PROVIDED BY THE OWNER.

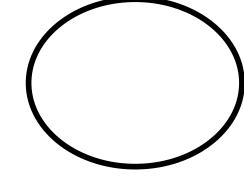

WILLIAMS \triangle S S O C I \triangle T E D △ R C H I T E C T S

> EIGHTEEN CORPORATE HILL DRIVE LITTLE ROCK, AR 72205 P 501·224·1900 F 501·224·0873 www.williamsdean.com





:SHEET TITLE

4 OCT 07

SITE PLAN

17 SEPT 07 :PROJECT NUMBER

:SHEET NUMBER


GENERAL NOTES:


- 1. PROVIDE 20" X 30" METAL ACCESS PANEL W/ LOCK IN THE CEILING OF EACH BLDG 'A' & 'B' UNIT.
- 2. EXTERIOR SHEATHING WILL BE 7/16" OSB WITH THE FOLLOWING NAILING PATTERN: 6" O.C. AT EDGE JOINTS AND 10" O.C. FIELD NAILING WITH 8D COATED BOX NAILS.
- 3. CONTRACTOR OPTION: NAILS FOR NAIL GUN APPLICATION OF EXTERIOR SHEATHING WILL BE: 8D DUO-FAST 03.23/8" X 0.113 FULL ROUND HEAD VINYL COATED NAILS OR APPROVED EQUAL. NAIL GUN = CN-350 OR EQUAL.
- 4. ALL SUBCONTRACTORS PENETRATING A FIRE RATED ASSEMBLY WILL BE REQUIRED TO FIRESEAL PENETRATION WITH APPROVED FIRE RATED SEALANT TO MAINTAIN ONE HOUR RATING, BEFORE THEIR WORK IS COMPLETE.
- 5. INSTALL WATER-RESISTANT GYPSUM WALLBOARD AT ALL WALLS IN BATHROOMS & MECHANICAL CLOSETS, AND AT ALL WET WALLS IN KITCHEN & LAUNDRY ROOMS. AT ONE HOUR RATED TENANT SEPARATION WALL AND INTERIOR BEARING WALLS, INSTALL 5/8" TYPE X WATER-RESISTANT GYPSUM

WALL TYPES

	EXTERIOR LOAD BEARING WALL, 2X4 @ 16" O.C. W/ 5/8" TYPE X GYP BI INTERIOR; MODULAR BRICK VENEER EXTERIOR
***************************************	EXTERIOR LOAD BEARING WALL, 2X4 @ 16" O.C. W/ 7/16" OSB & 5/8" TYPE X GYP BD ON EXTERIOR & 5/8" TYPE X GYP BD INTERIOR
	LOAD BEARING TENANT SEPARATION WALL, 2X4 OR 2X6 @ 16" O.C. W/ 5/8" TYPE X GYP BD EACH SIDE
	INTERIOR LOAD BEARING WALL, 2X4 OR 2X6 @ 16" O.C. W/ 5/8" TYPE X GYP BD EACH SIDE -SEE STRUCTURAL FOR ANCHOR BOLT REQUIREMENTS
	INTERIOR WALL, 2X4 @ 16" O.C. W/ 1/2" GYP BD EACH SIDE
7//////	GYP BD FURRED DOWN AREAS TO 7'-0" A.F.F.

NOTE: SEE SHEET A-3.5 FOR DESCRIPTIONS OF UL RATED DESIGN ASSEMBLIES.

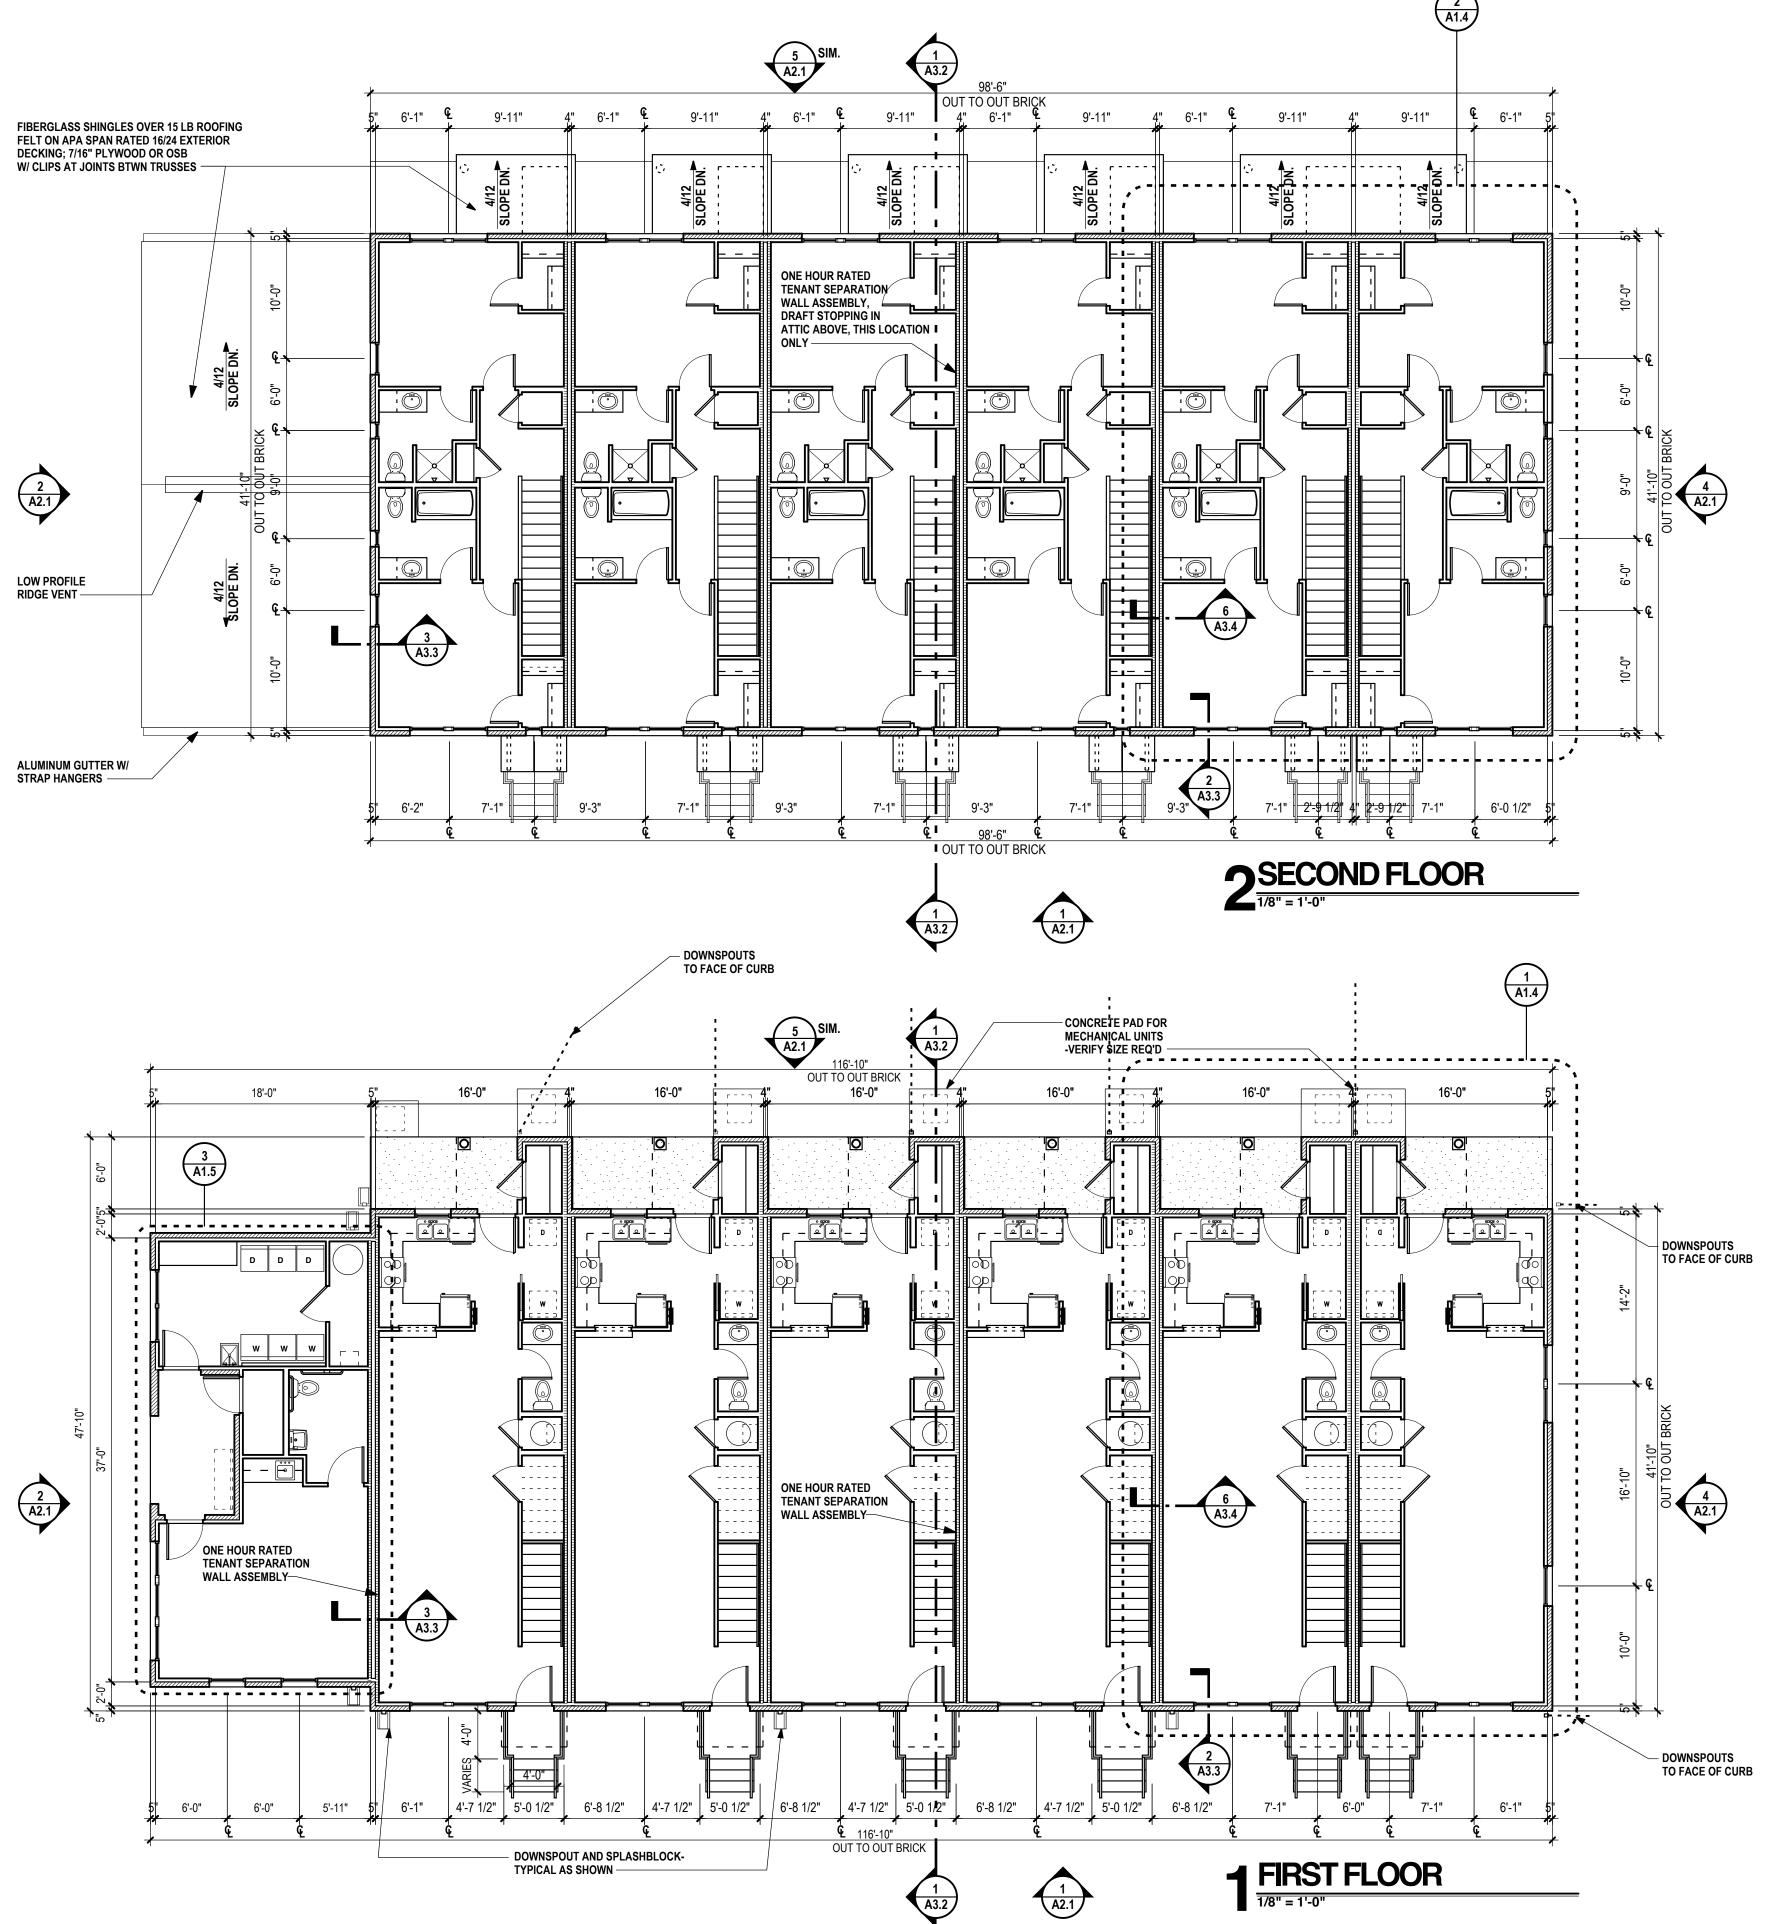

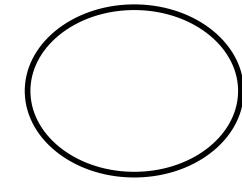

WILLIAMS

 \triangle S S O C I \triangle T E D △ R C H I T E C T S

EIGHTEEN CORPORATE HILL DRIVE LITTLE ROCK, AR 72205 P 501·224·1900 F 501·224·0873 www.williamsdean.com



BUILDING 'A' FLOOR PLAN

17 SEPT 07


GENERAL NOTES:


- 1. PROVIDE 20" X 30" METAL ACCESS PANEL W/ LOCK IN THE CEILING OF EACH BLDG 'A' & 'B' UNIT.
- 2. EXTERIOR SHEATHING WILL BE 7/16" OSB WITH THE FOLLOWING NAILING PATTERN: 6" O.C. AT EDGE JOINTS AND 10" O.C. FIELD NAILING WITH 8D COATED BOX NAILS.
- 3. CONTRACTOR OPTION: NAILS FOR NAIL GUN APPLICATION OF EXTERIOR SHEATHING WILL BE: 8D DUO-FAST 03.23/8" X 0.113 FULL ROUND HEAD VINYL COATED NAILS OR APPROVED EQUAL. NAIL GUN = CN-350 OR EQUAL.
- 4. ALL SUBCONTRACTORS PENETRATING A FIRE RATED ASSEMBLY WILL BE REQUIRED TO FIRESEAL PENETRATION WITH APPROVED FIRE RATED SEALANT TO MAINTAIN ONE HOUR RATING, BEFORE THEIR WORK IS COMPLETE.
- 5. INSTALL WATER-RESISTANT GYPSUM WALLBOARD AT ALL WALLS IN BATHROOMS & MECHANICAL CLOSETS, AND AT ALL WET WALLS IN KITCHEN & LAUNDRY ROOMS. AT ONE HOUR RATED TENANT SEPARATION WALL AND INTERIOR BEARING WALLS, INSTALL 5/8" TYPE X WATER-RESISTANT GYPSUM WALLBOARD.

WALL TYPES

	EXTERIOR LOAD BEARING WALL, 2X4 @ 16" O.C. W/ 5/8" TYPE X GYP BI INTERIOR; MODULAR BRICK VENEER EXTERIOR
***************************************	EXTERIOR LOAD BEARING WALL, 2X4 @ 16" O.C. W/ 7/16" OSB & 5/8" TYPE X GYP BD ON EXTERIOR & 5/8" TYPE X GYP BD INTERIOR
	LOAD BEARING TENANT SEPARATION WALL, 2X4 OR 2X6 @ 16" O.C. W/ 5/8" TYPE X GYP BD EACH SIDE
<u></u>	INTERIOR LOAD BEARING WALL, 2X4 OR 2X6 @ 16" O.C. W/ 5/8" TYPE X GYP BD EACH SIDE -SEE STRUCTURAL FOR ANCHOR BOLT REQUIREMENTS
	INTERIOR WALL, 2X4 @ 16" O.C. W/ 1/2" GYP BD EACH SIDE
7//////	GYP BD FURRED DOWN AREAS TO 7'-0" A.F.F.

NOTE: SEE SHEET A-3.5 FOR DESCRIPTIONS OF UL RATED DESIGN ASSEMBLIES.

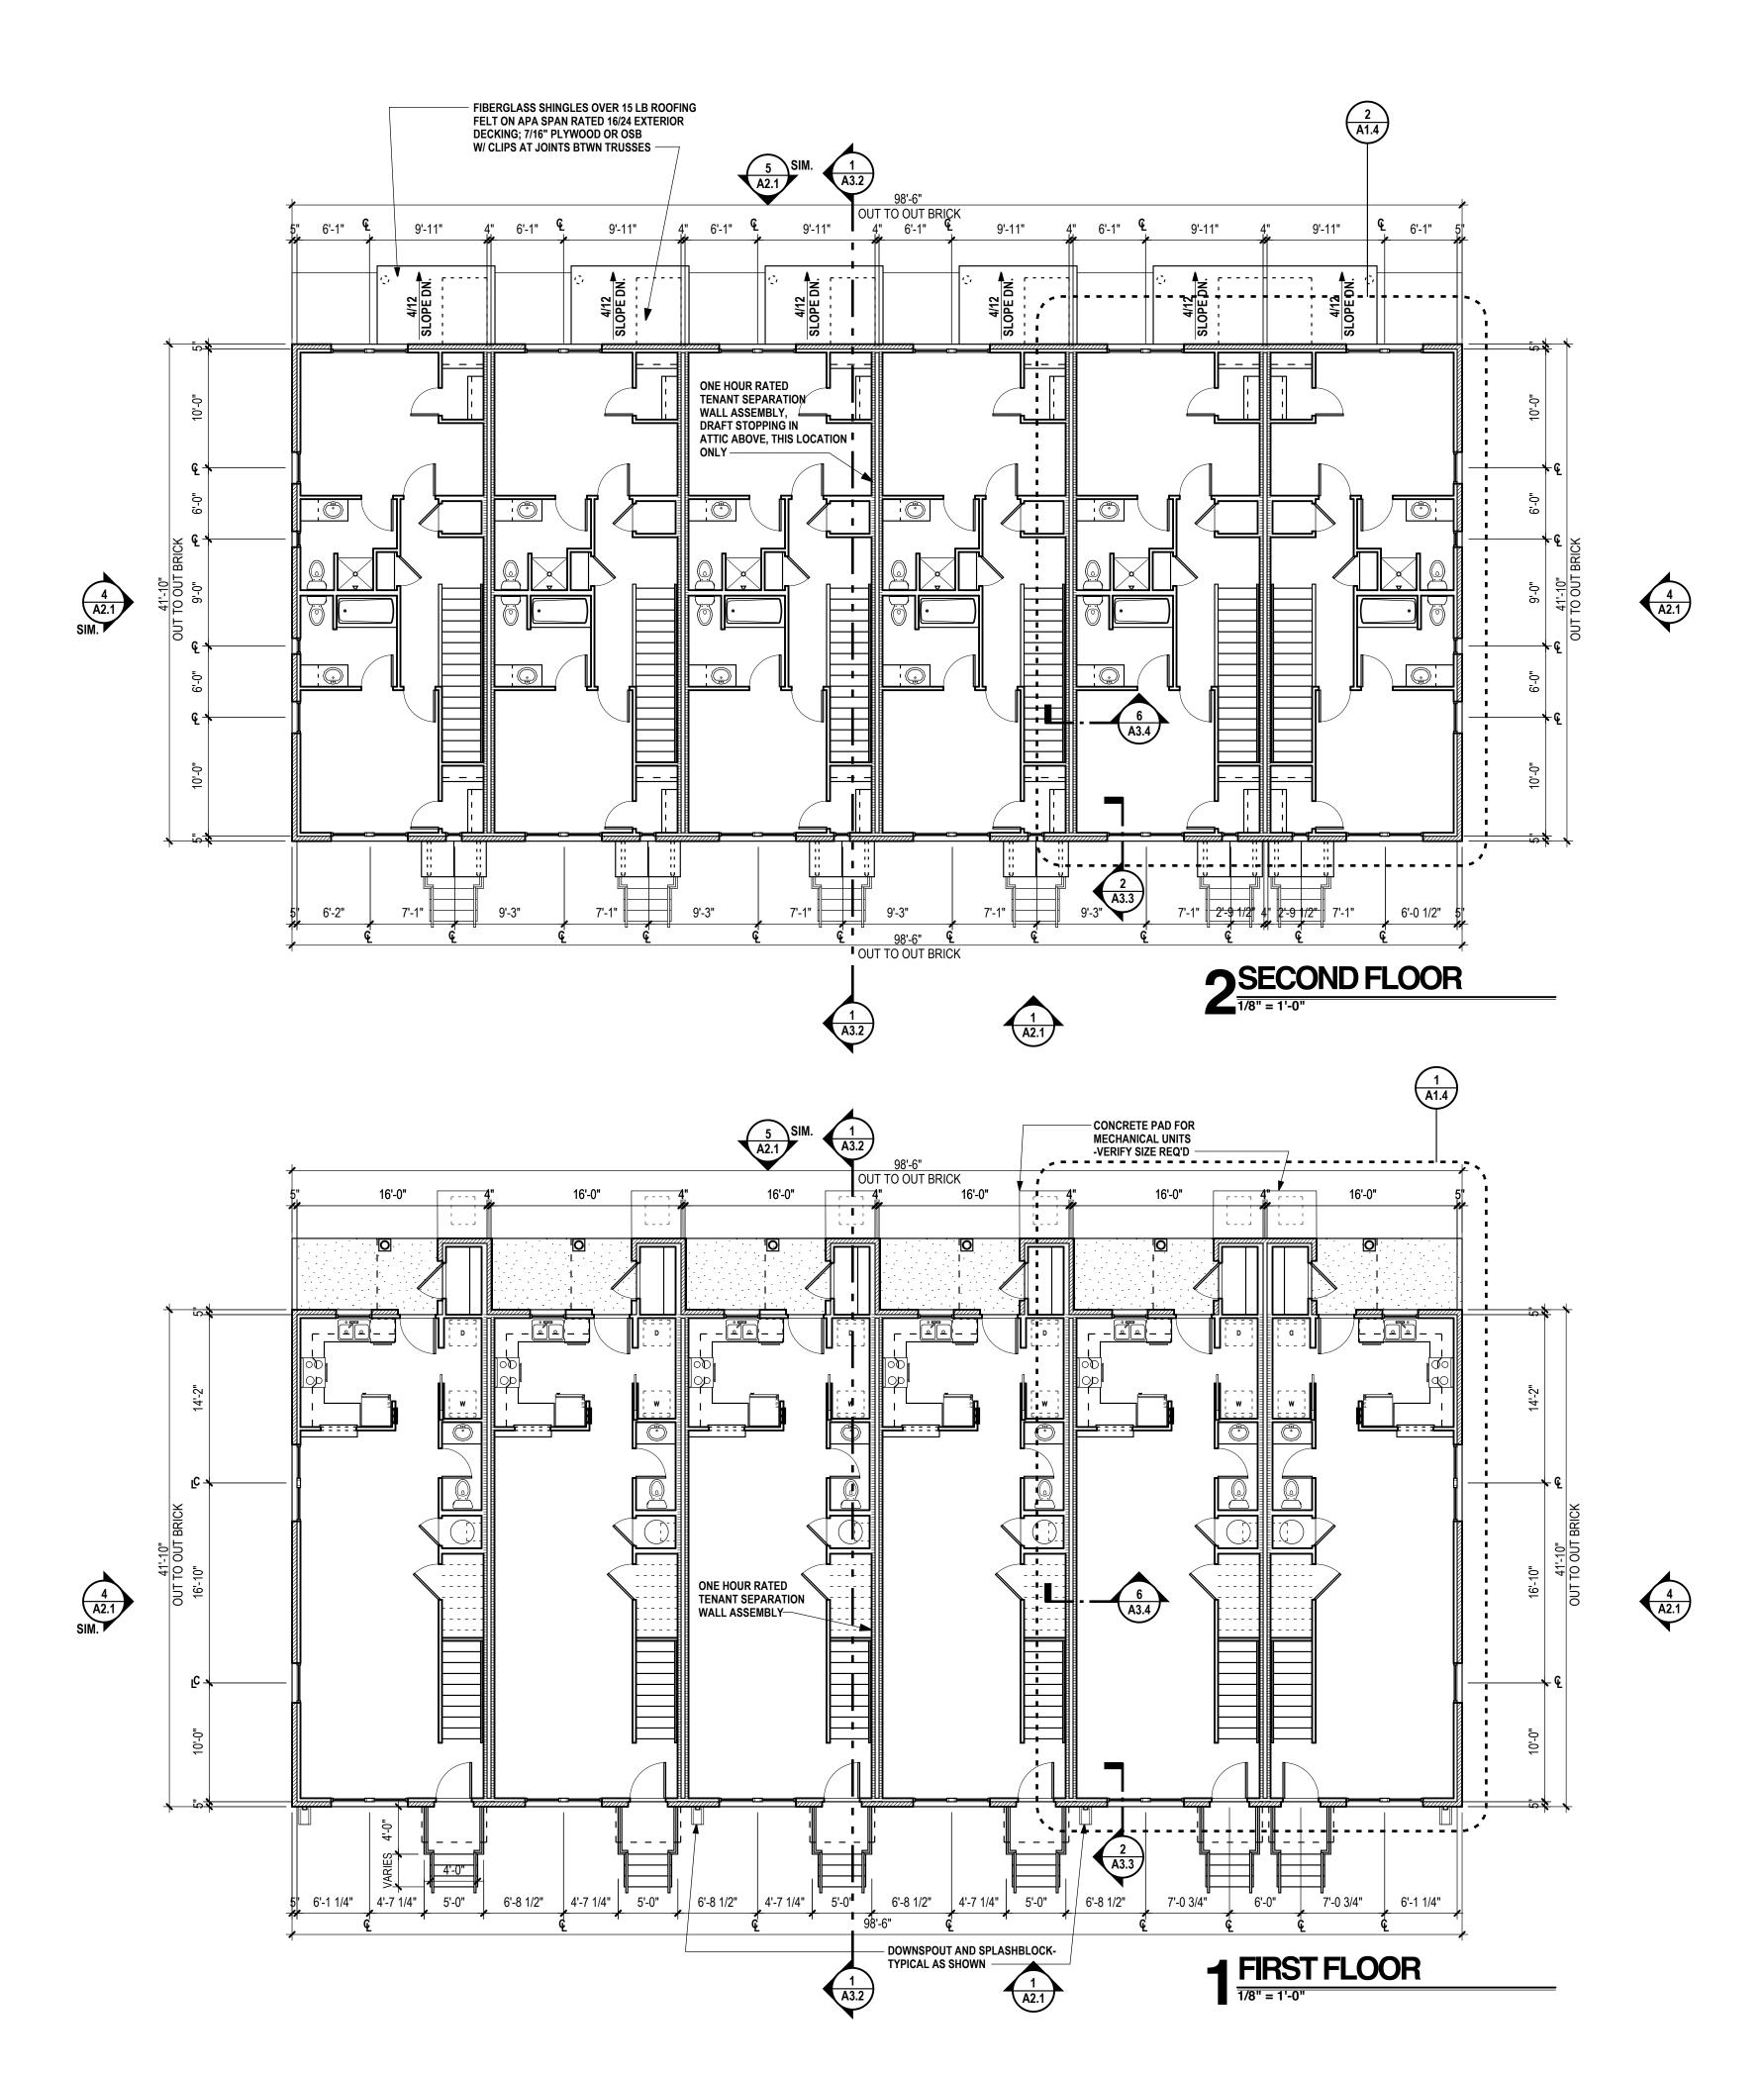

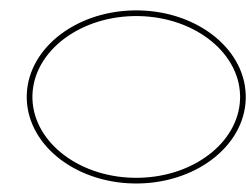


WILLIAMS & DEAN

△ R C H I T E C T S

 \triangle 550CI \triangle TED

E I G H T E E N
CORPORATE HILL DRIVE
LITTLE ROCK, AR 72205
P 501 · 224 · 1900
F 501 · 224 · 0873
WWW.WILLIAMSDEAN.COM

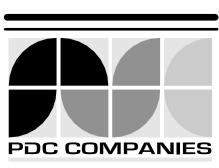

LLEGE

VDRIX COLL

SHEET TITLE
BUILDING 'B' FLOOR
PLAN


REVISION: :DATE

17 SEPT 07 :ISSUE DATE

07-076 :PROJECT NUMBER

Δ1_2

NOTE: SEE SHEET A-3.5 FOR DESCRIPTIONS OF UL RATED DESIGN ASSEMBLIES.

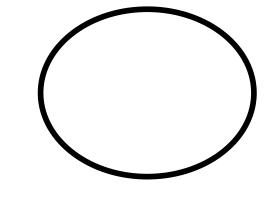


WILLIAMS

& DEAN

ASSOCIATED

ARCHITECTS


E I G H T E E N
CORPORATE HILL DRIVE
LITTLE ROCK, AR 72205
P 501·224·1900
F 501·224·0873
WWW.WILLIAMSDEAN.COM

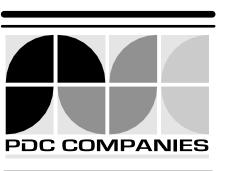

)LLEGE

HENDRIX COL

SHEET TITLE
BUILDING 'C' FLOOR
PLAN

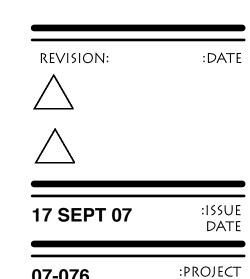



-076 SPROJECT NUMBER :SHEET NUMBER

A 1 2

2 ENLARGED SECOND FLOOR PLAN - BUILDINGS 'A' & 'B'



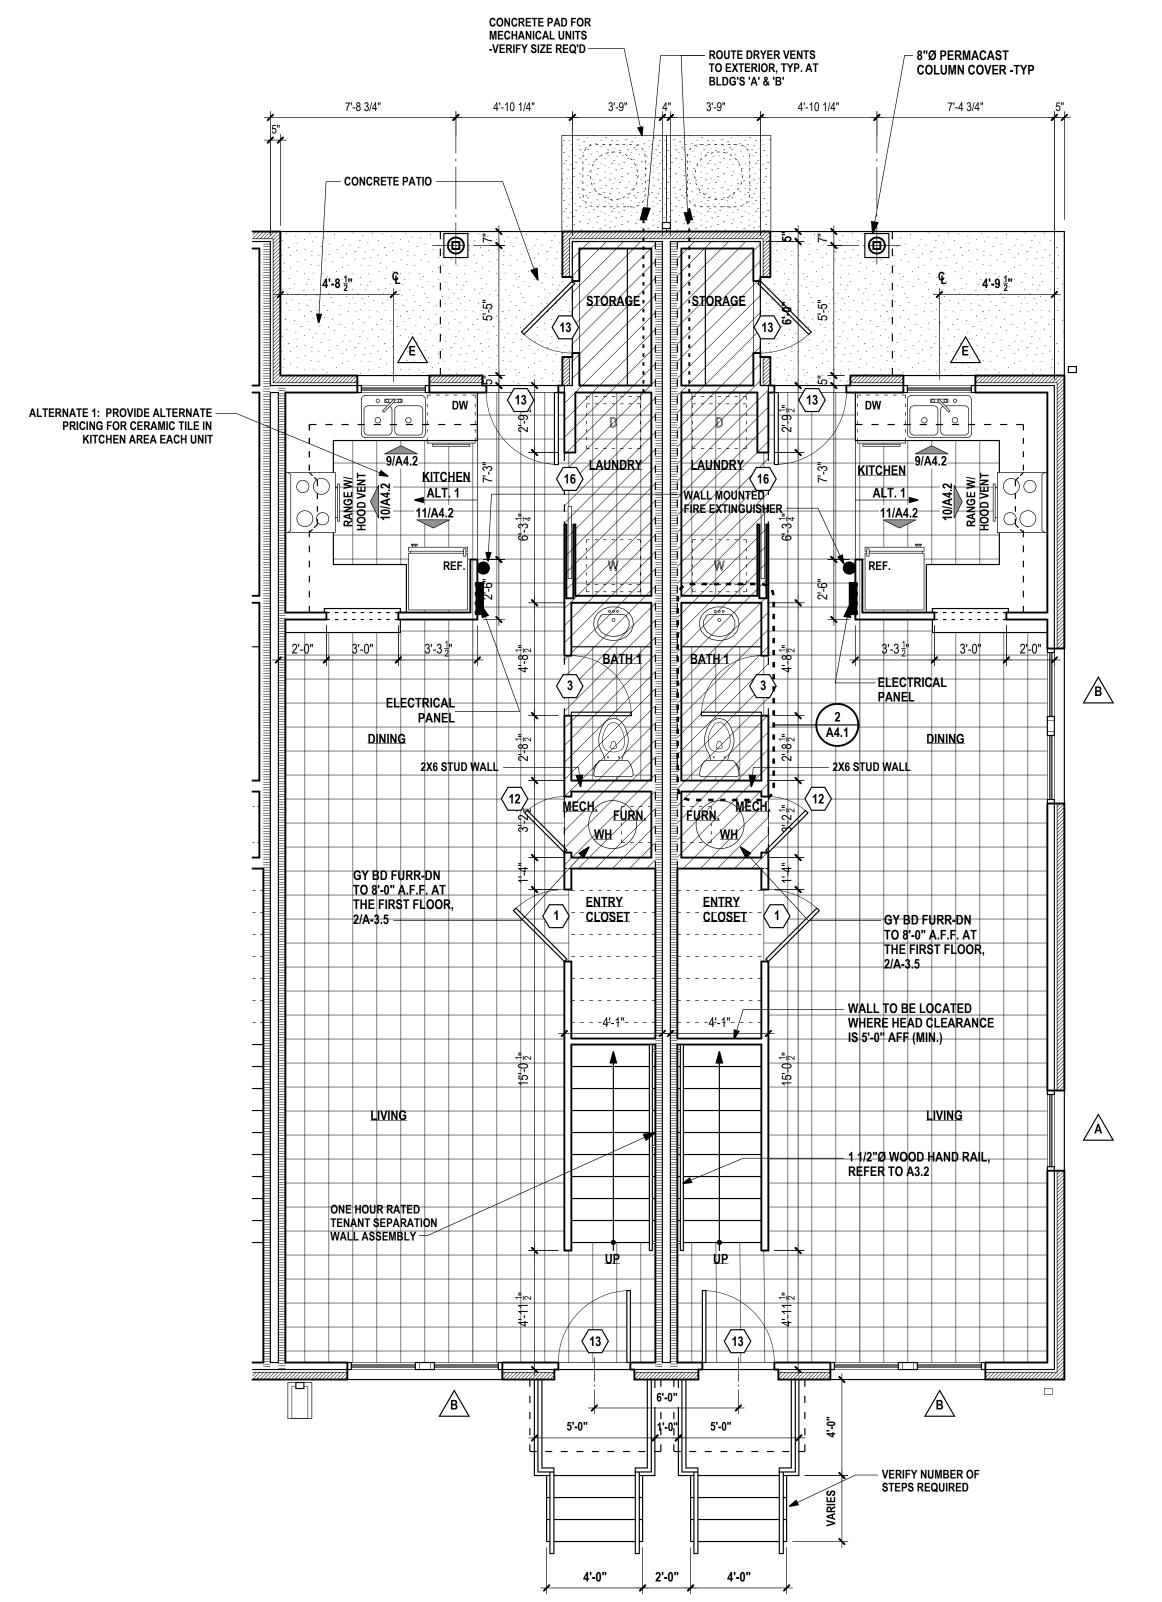

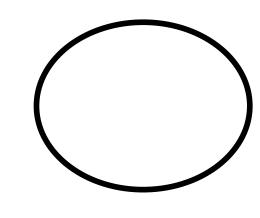

WILLIAMS $E \wedge N$ ASSOCIATED

△ R C H I T E C T S

EIGHTEEN CORPORATE HILL DRIVE LITTLE ROCK, AR 72205 P 501·224·1900 F 501·224·0873 www.williamsdean.com



:SHEET TITLE BUILDING 'A' & 'B' PARTIAL ENLARGED FLOOR PLANS

17 SEPT 07

:SHEET NUMBER





TWO HOUR RATED TENANT SEPARATION WALL ASSEMBLY-

8'-1 ½"

CONCRETE PAD FOR

MECHANICAL UNITS

-VERIFY SIZE REQ'D

4 A4.1

8'-1 ½"

 $2'-3\frac{1}{2}"$


BEDROOM 2



BUILDING 'C' PARTIAL ENLARGED FLOOR PLANS

	EVISION:	:DAT
17	SEPT 07	:ISSU DAT
_		
07	070	·DROIFC


07-076 NUMBER

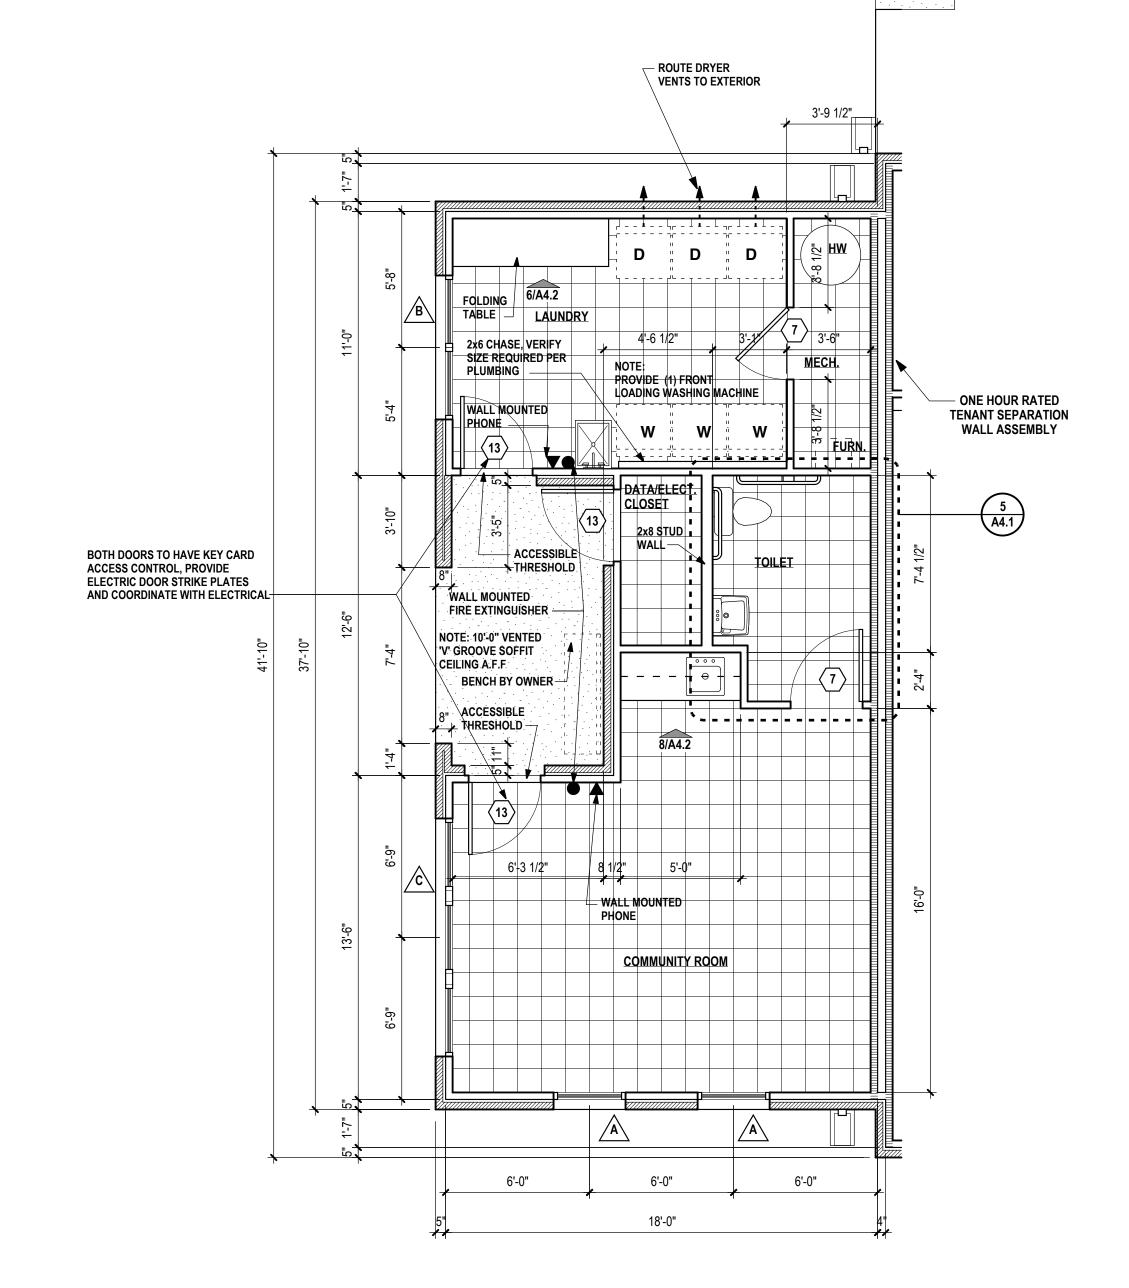

3 LAUNDRY & COMMUNITY AREA

CONCRETE PAD FOR

MECHANICAL UNITS -VERIFY SIZE REQ'D

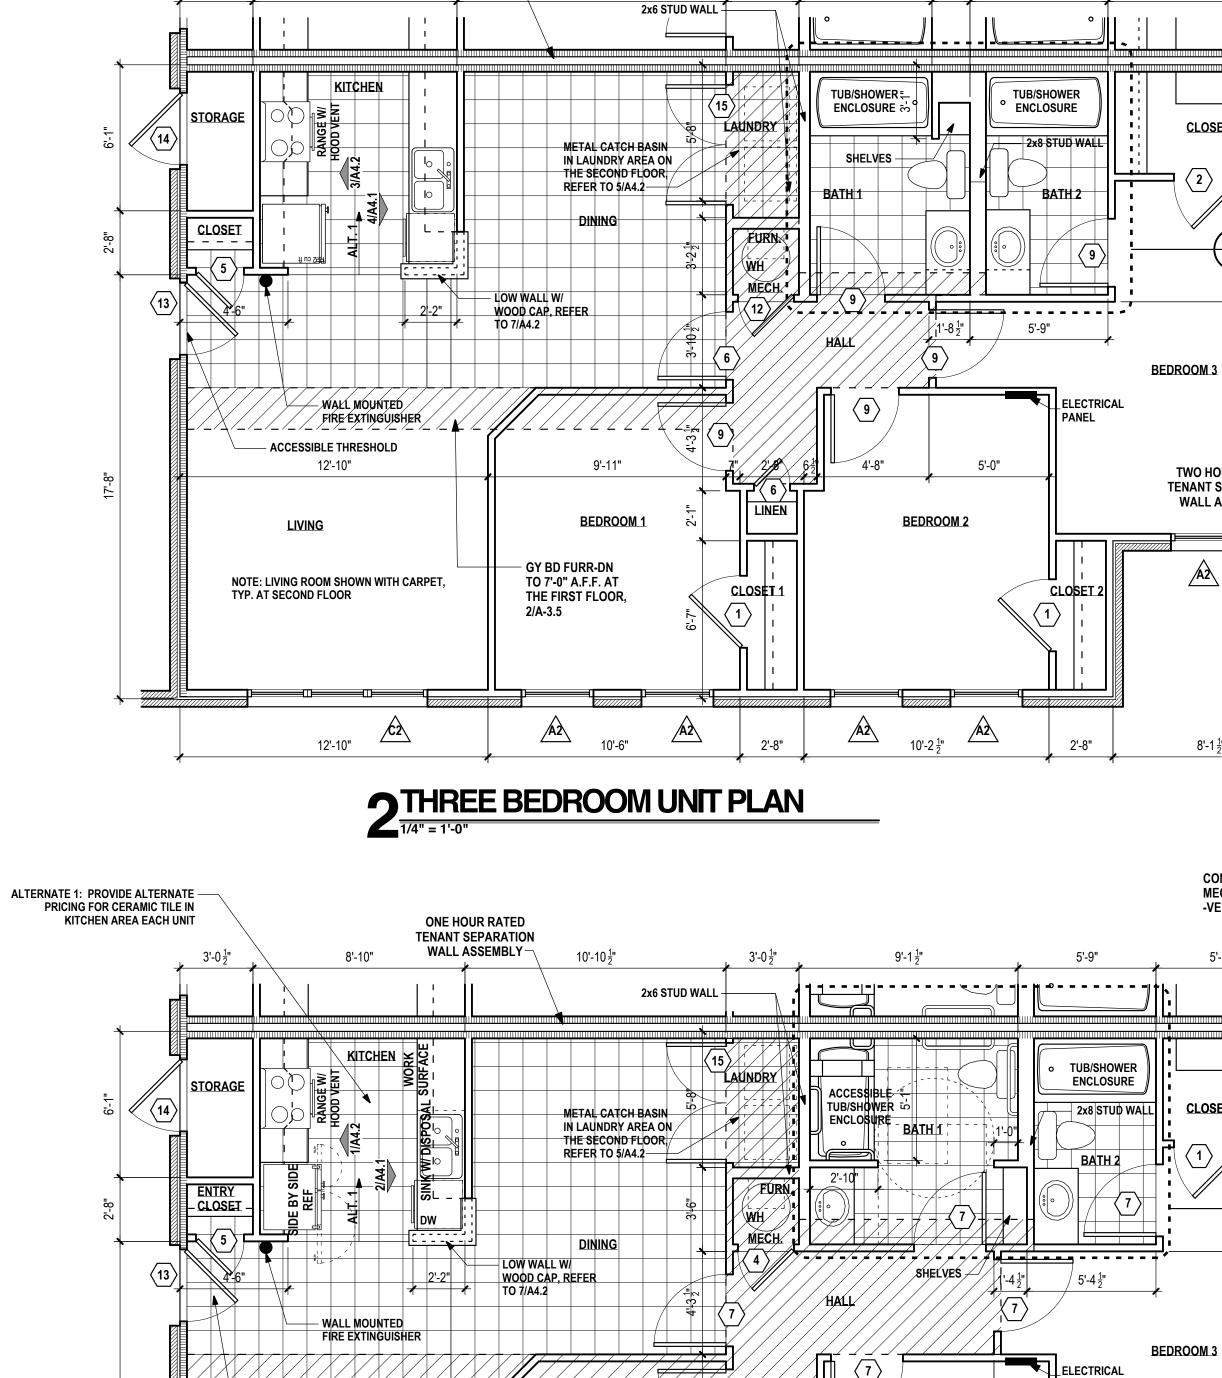

9'-11"

BEDROOM 1

10'-6"

1 FULLY ACCESSIBLE THREE BEDROOM UNIT PLAN

1/4" = 1'-0"

— GY BD FURR-DN TO 8'-0" A.F.F. AT THE FIRST FLOOR, 2/A-3.5

ACCESSIBLE THRESHOLD 12'-10"

NOTE: LIVING ROOM SHOWN WITH VCT, TYP. AT FIRST FLOOR

12'-10"

ONE HOUR RATED TENANT SEPARATION WALL ASSEMBLY-

11'-2 ½"

BRICK SEMICICULAR ARCH

ENTRY ON GRADE

4 Bldg A East, Bldg B South Elevation

BLDG B NORTH ELEVATION SIM, REVERSED

ARCHITECTURAL LAMINATED COMPOSITION

BRICK SOLDIER COURSE -CONT.

BRICK SOLDIER COURSE -CONT.

18' -5" A.F.F. ROOF BEARING HT

TOP OF 2ND FLR

BRICK LINTELS AND SILLS

0'-0" F.F.E.

BRICK VENEER

9'-1 1/8" A.F.F. 2ND FLR BEARING HT


SHINGLES WITH CONT. CONCEALED RIDGE VENT

PREFINISHED METAL GUTTER AND DOWNSPOUTS



3 BUILDING 'B' FRONT ST. ELEVATION

1/8" = 1'-0"

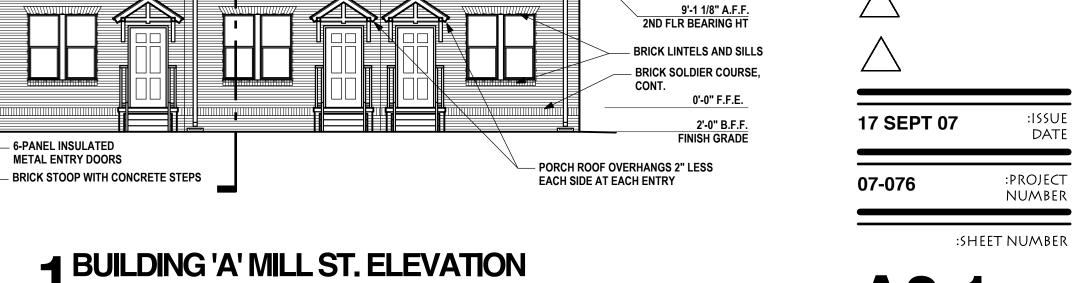

:SHEET TITLE **BUILDING A & B -BUILDING ELEV.**

WILLIAMS

 \triangle 550CI \triangle TED

△ R C H I T E C T S

EIGHTEEN

CORPORATE HILL DRIVE

LITTLE ROCK, AR 72205

P 501·224·1900

F 501·224·0873 www.williamsdean.com

PDC COMPANIES

- MASONRY CONTROL JOINTS

AT INSIDE CORNERS, TYPICAL

DOWNSPOUTS 18' -5" A.F.F. ROOF BEARING HT

BRICK VENEER

10'-3 7/8" A.F.F. TOP OF 2ND FLR

9'-1 1/8" A.F.F. 2ND FLR BEARING HT

3'-6" B.F.F. FINISH GRADE -VERIFY

- PORCH ROOF OVERHANGS 2" LESS EACH SIDE AT EACH ENTRY

- BRICK LINTELS AND SILLS

0'-0" F.F.E.

BRICK SOLDIER COURSE,

ARCHITECTURAL LAMINATED

PREFINISHED METAL

BRICK VENEER

GUTTER AND DOWNSPOUTS 18' -5" A.F.F. ROOF BEARING HT

TOP OF 2ND FLR

ARCHITECTURAL LAMINATED COMPOSITION SHINGLES WITH CONT. LOW PROFILE CONCEALED RIDGE VENT

- PREFINISHED METAL GUTTER AND

BRICK SOLDIER COURSE -CONT.

COMPOSITION SHINGLES WITH CONT. LOW PROFILE CONCEALED RIDGE VENT

BRICK SOLDIER COURSE -CONT. REVISION:

2 BLDG A WEST ELEVATION

1/8" = 1'-0"

DECORATIVE LIGHTING FIXTURES

REFER TO GRADING PLAN FOR GRADES THIS AREA BUILDING B SOUTH, VERIFY STEPS REQUIRED AND RAILING REQUIREMENTS

ROOF TO WALL COUNTER — FLASHING AT PORCH


ROOF TO WALL COUNTER FLASHING AT LOW ROOF

MASONRY CONTROL JOINTS

AT INSIDE CORNERS, TYPICAL-




FINISH GRADE SEE SITE PLAN FOR DOWNSPOUT LOCATIONS TO FACE OF CURB NOTE: BUILDING B REAR ELEVATION SIMILAR. REFER TO GRADING PLAN FOR GRADES ON SOUTH END AND PROVIDE STAIR RAILINGS AND GUARDRAILS AT THE PATIOS WHERE GRADE CHANGE IS 30" OR REQUIRE (3) STEPS.

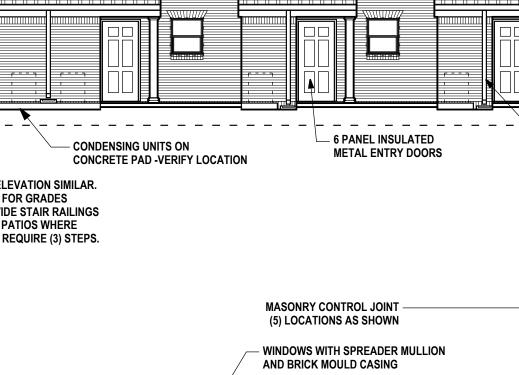


MASONRY CONTROL JOINT (5) LOCATIONS AS SHOWN

AND BRICK MOULD CASING

WINDOWS WITH SPREADER MULLION -

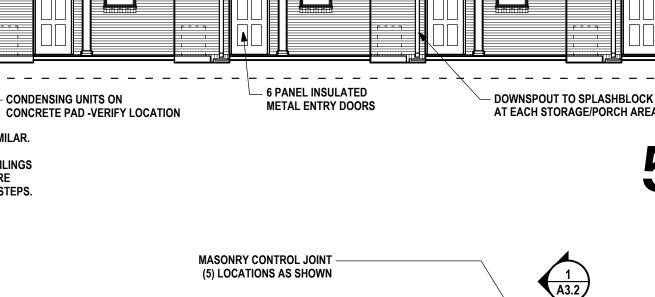


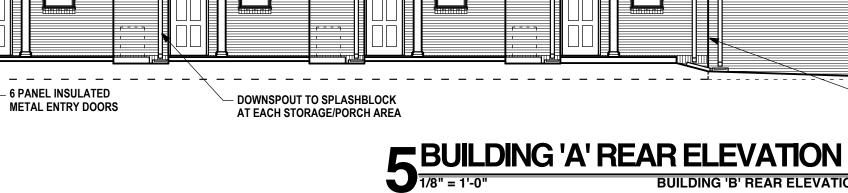


METAL ENTRY DOORS

BRICK STOOP WITH CONCRETE STEPS



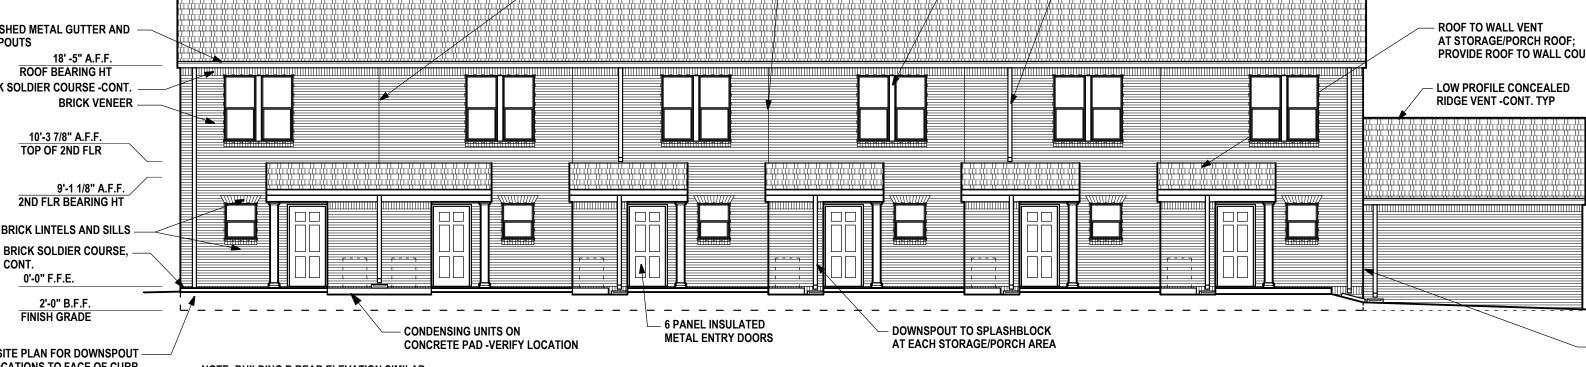

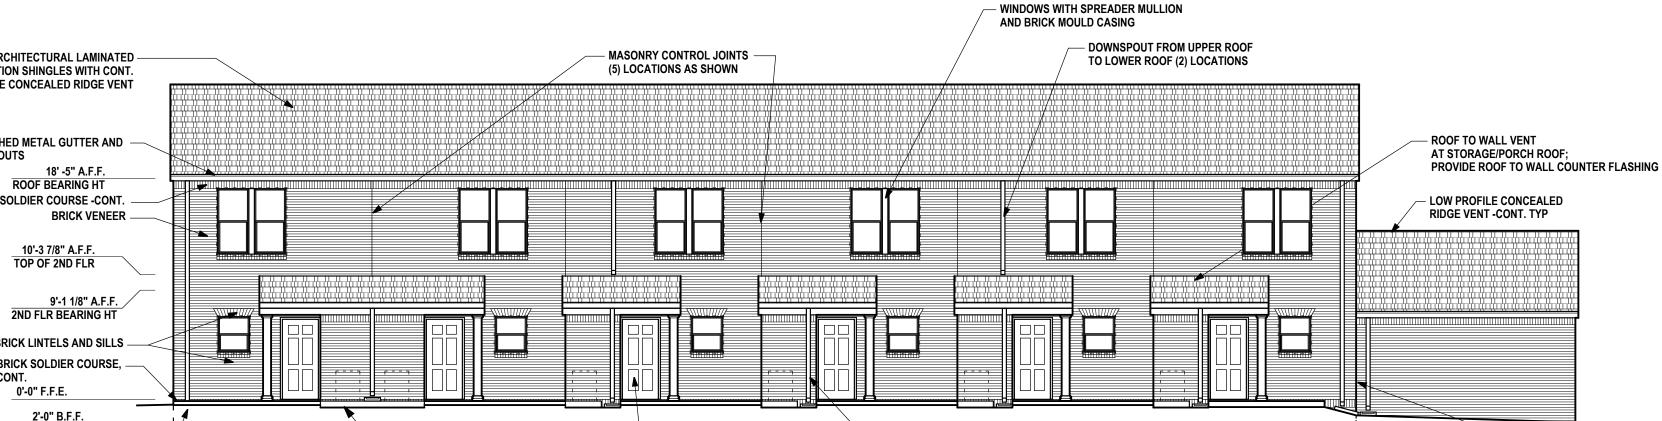

— WOOD FRAMED ROOF

- WOOD FRAMED ROOF

WITH BRACKETS

METAL RAILINGS

- METAL HANDRAILINGS

WITH BRACKETS

PREFINISHED METAL GUTTER AND -DOWNSPOUTS BRICK SOLDIER COURSE -CONT. -BRICK LINTELS AND SILLS -BRICK SOLDIER COURSE,

ARCHITECTURAL LAMINATED -

COMPOSITION SHINGLES WITH CONT. LOW PROFILE CONCEALED RIDGE VENT

SOLDIER COURSE AT FINISH FLOOR LEVEL -

10FT CEILING HEIGHT AT ENTRY


MASONRY CONTROL JOINTS

AT INSIDE CORNERS, TYPICAL

CEMENT FIBER SIDING AT END -OF BACK ENTRY PORCH


0'-0" F.F.E.


8" 'PERMACAST' COLUMN

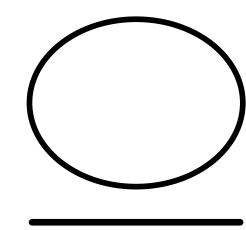

WILLIAMS
& DEAN
ASSOCIATED
ARCHITECTS

E I G H T E E N CORPORATE HILL DRIVE LITTLE ROCK, AR 72205 P 501 · 224 · 1900 F 501 · 224 · 0873 WWW.WILLIAMSDEAN.COM

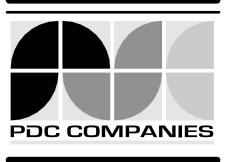

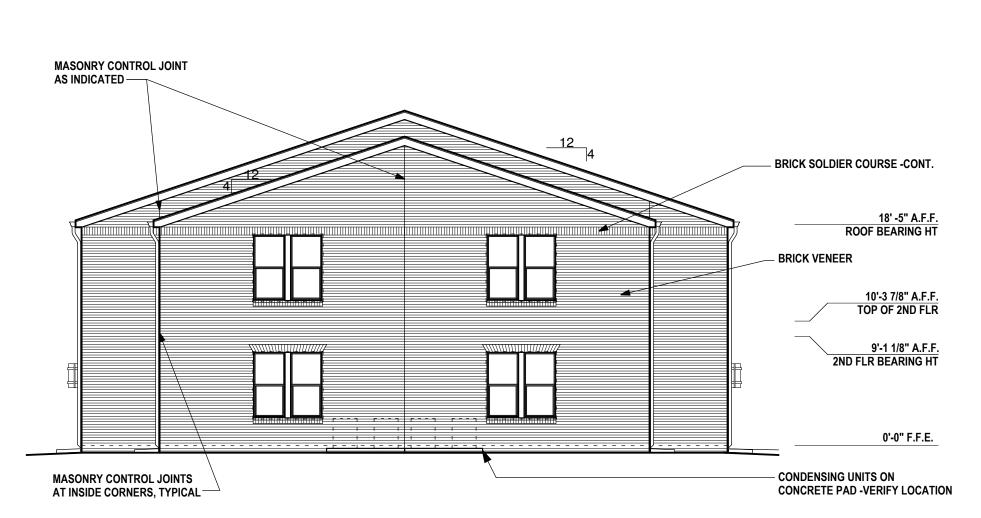

2 BUILDING 'C' WEST ELEVATION

1/8" = 1'-0"



BRICK SOLDIER COURSE -CONT.

BRICK VENEER

- CONDENSING UNITS ON

CONCRETE PAD -VERIFY LOCATION

ROOF BEARING HT

10'-3 7/8" A.F.F. TOP OF 2ND FLR

0'-0" F.F.E.

9'-1 1/8" A.F.F. 2ND FLR BEARING HT

MASONRY CONTROL JOINT

3 BUILDING 'C' EAST ELEVATION

AS INDICATED —

1 BUILDING 'C' NORTH ELEVATION

| 1/8" = 1'-0" | SOUTH ELEVATION SIMILAR

A2.2

BUILDING C -BUILDING ELEV.

REVISION:

17 SEPT 07

:SHEET TITLE

:PROJECT

NUMBER

:SHEET NUMBER